TP-00725

NOAA FORM 76-35

U.S. DEPARTMENT OF COMMERCE
NATIONAL OCEANIC AND ATMOSPHERIC ADMINISTRATION
NATIONAL OCEAN SURVEY

DESCRIPTIVE REPORT

Type of Survey Shoreline. Map
Job No. CM-7807 Map No. TP-00725
Classification No. Edition No
LOCALITY
Massachusetts State
General Locality Nantucket Sound
Locality Monomoy Island
19 78 TO 19
REGISTRY IN ARCHIVES
DATE

☆ U.S. GOVERNMENT PRINTING OFFICE: 1974-762-901

NOAA FORM 76-36A U. S. DEPARTMENT OF COMMERCE		00705
NOAA FORM 76-36A (3-72) U. S. DEPARTMENT OF COMMERCE NATIONAL OCEANIC AND ATMOSPHERIC ADMIN.	TYPE OF SURVEY	SURVEY TP. 00725
	D ORIGINAL	MAPEDITION NO. (1)
; DESCRIPTIVE REPORT - DATA RECORD	RESURVEY	MAP CLASS III
DESCRIPTIVE REPORT - DATA RECORD	REVISED	лов *ħ - <u>CM-7807</u>
PHOTOGRAMMETRIC OFFICE		
Photogrammetry Division (Rockville)		ING MAP EDITION
Photogrammetry Division (Rockviite)	TYPE OF SURVEY	JOB PH
OFFICER-IN-CHARGE	RESURVEY	SURVEY DATES:
Cdr. Walter Simmons	REVISED	19 TO 19
I. INSTRUCTIONS DATED 1. OFFICE	9	FIELD
I, OFFICE		rieto
Instructions-OFFICE-3/21/78 Instructions-OFFICE-Change No. 1 Amendment to Instructions	Instructions-FI	ELD-3/14/78
II. DATUMS	OTHER (Specify)	
1. HORIZONTAL: 💢 1927 NORTH AMERICAN	OTTIEN (Specify)	
X MEAN HIGH-WATER	OTHER (Specify)	
2. VERTICAL: MEAN LOW-WATER MEAN LOWER LOW-WATER MEAN SEA LEVEL	National Geodet of 1929	ic Vertical Datum
3. MAP PROJECTION	4. (GRID(S)
Lambert Conformal Conic	Massachusetts	ZONE Mainland Zone
5. SCALE 1:20,000	STATE	ZONE
III. HISTORY OF OFFICE OPERATIONS		<u> </u>
OPERATIONS	NAME	DATE
1. AEROTRIANGULATION BY	R. Fisher	4/78
METHOD: Analytic LANDMARKS AND AIDS BY	NA	
2. CONTROL AND BRIDGE POINTS PLOTTED BY	H. Jones	4/11/78
METHOD: Coradomat CHECKED BY	NA	4/10/70
3. STEREOSCOPIC INSTRUMENT PLANIMETRY BY	G. Fromm G. Fromm	4/19/78 4/19/78
COMPILATION CHECKED BY INSTRUMENT; WITH B-8S CONTOURS BY	NA NA	4/13/70
SCALE: 1:20,000 CHECKED BY	NA	
4. MANUSCRIPT DELINEATION PLANIMETRY BY	G. Fromm	2/1/80
CHECKED BY	R.W. Rodkey	2/15/80
MRTHOD: Smooth Drafting CONTOURS BY	NA	
CHECKED BY	NA	
SCALE: 1:20,000 HYDRO SUPPORT DATA BY	NA NA	
CHECKED BY	NA NA	
5. OFFICE INSPECTION PRIOR TO FIELD EDIT BY	NA	
6. APPLICATION OF FIELD EDIT DATA CHECKED BY	NA	
7. COMPILATION SECTION REVIEW BY		2/20/00
	G. Fromm	2/20/80
8. FINAL REVIEW BY	E.L.Rolle	3/21/80
8. FINAL REVIEW BY 9. DATA FORWARDED TO PHOTOGRAMMETRIC BRANCH BY	E.L.Rolle G. Fromm	3/21/80 2/21/80
	E.L.Rolle	3/21/80

1

NOAA FORM 76-36B

U. S. DEPARTMENT OF COMMERCE NATIONAL OCEANIC AND ATMOSPHERIC ADMINISTRATION NATIONAL OCEAN SURVEY

COMPILATION SOURCES

TP-00725

. COMPILATION PHO							
CAMERA(S) Wild RC	-8(E) FL=			PHOTOGRAPHY EGEND		REFERE	ENCE
TIDE STAGE REFEREN PREDICTED TIDES TO REFERENCE STAT TIDE CONTROLLE	ICE		(C) COLOR (P) PANCHE (I) INFRAR	DOLL	Eas MERIDIAN 751	stern th	X STANDARD
NUMBER AND		DATE	TIME	SCALE		GE OF T	IDE
78Z(C) 2291, 9 and 2301, 03, 78B(C) 6796-68	93, 95, 97, 05, 07		1126-1130		The stage inapplical color pho	of t	ide is
Mean High Wate 78 E(I) 1232R-	-1240R	7/12/78	1525-1530	1:20,000	Refer to		
Mean Low Water 78 E(I) 1216R-		7/12/78	1022-1026	1:20,000	for tide	stage	informatio
listed at	ce of the foove under	neane high wa	efer to par	is the high w ragraph #31 o	water infrar of the Compi	ed pho lation	tography Report
	•						
The source listed al	αρρτοχ ce of the r bove under	mate mean low was	ter line is efer to pa	s the low wat ragraph #31 c	er infrared of the Compi	photo lation	ography Report
listed al	approx ce of the nove under th this De	mate mean low war Item l. Ro scriptive Ro	ter line is efer to pare eport.	s the low wat ragraph #31 c	of the Compi	lation	n Report
The source listed all bound with the contemporary	approxice of the roove under the this Des	mate mean low war Item 1. Re scriptive Re	ter line is efer to pare eport.	s the low wat ragraph #31 o	of the Compi	lation	n Report

NOAA FORM 76-36B(1) (7-75)

3

U. S. DEPARTMENT OF COMMERCE
NATIONAL OCEANIC AND ATMOSPHERIC ADMINISTRATION
NATIONAL OCEAN SURVEY

TIDE - COORDINATED PHOTOGRAPHY

TP _ 00725

ď		TP _ 00/25		
	LOCATION AND PHOTOGRAPHY	TIDE STATIONS (In operation at time of photography)	STAGE OF TIDE	MEAN RANGE
		Boston, Massachusetts (Reference Station)		9.5 ⁻ Ft.
	78 E(I) 1216R-1224R	Chatham (Outer coast) (Sub. Sta.)	+0.36 MLW	6.7 Ft.
		Chatham (Inner coast) (Sub Sta.)	+0.5 MLW	3.6 Ft.
		Monomoy Point (Sub Sta.)	+0.1 MLW	3.7 Ft.
	78 E(I) 1232R-1240R	Chatham (Outer coast) (Sub Sta.)	-0.87 MHW	6.7 Ft.
		Chatham (Inner coast) (Sub Sta.)	-1.33 MHW	3.6 Ft.
		Monomoy Point (Sub Sta.)	≏0.5 MHW	3.7 Ft.
	<u>NOTE</u> :	Only the reference station was in operation at time of photography.		·
				;
ı		<u> </u>	1	<u> </u>

REMARKS: 1. See additional tide data on the following 4 pages bound with this Descriptive Report.

The mean ranges of tide were taken from the 1978 TIDE TABLES publication. 2.

Minimal water penetration is apparent on the mean low water photography. Refer to paragraph 35 of the Compilation Report bound with this Descriptive Report.

CM-7807 Monomoy Island, MA.

NOTE

The attached working copies were furnished by the Tides and Water Levels Division (C23). The times shown are Eastern Standard Time and correspond to when the infrared photography was taken. The mean ranges of tide were taken from the appropreiate 1978 Tide Tables publication.

The only tide gage (reference station) in operation at this time was "Boston, Mass.". Hourly time and height differences, as listed in the 1978 Tide Tables for the attached suborniate station, were applied to the reference station records to derive the tide stages furnished.

Photogrammetry Div.


January 1980

TIDE DATA

	_			
Monomo	y Pt., MA.			
0				
12 July	78 *Easter S	tandard Time		
\mathcal{O}				
at 102	4 * height was 8 * height was 3 e of + lo 3.	. O. I feet abo	ve MLW	
at 1528	* height was	2 3.2 feet at	we MLW	
Ra-	se of +16 3,	7 H		···-
		PH)		
·	Briah 	K. Connor ides and water Lavel	s Dinisión	
	6233-1	Datum and Informa	tion Brough	
		December 1979		r
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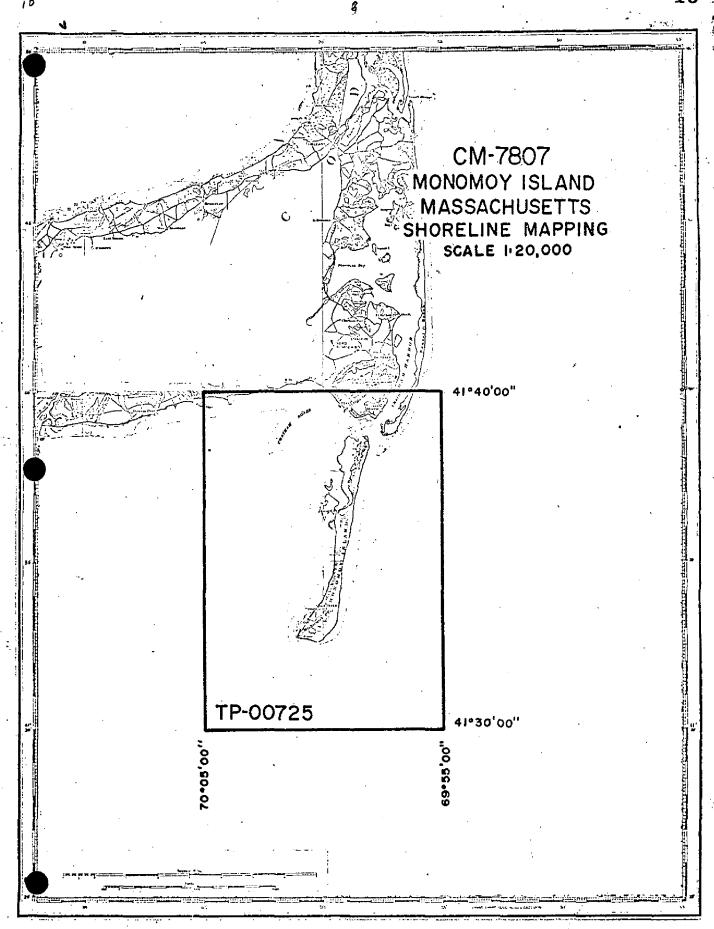
TIDE DATA

* Eastern Standard Time
Chatham (Inside)
10.4 hours 12 July 78 = 0.5 feet above MLW.
15,5 * hours 12 July 78 = 2.27 Rest above MLW:
Chatham (Outer Coast)
10.4 *Lours: 12 July 78 = 0.36 feet above MLW 15.5 *hours 12 July 78 = 5.83 feet above MLW
15.5 hours 12 July 78 = 5.83 feet above MLW
(P)
Bria K. Connor
C 233 Tides and Water Levels Division
Datom and Information Branch
December 1979
1

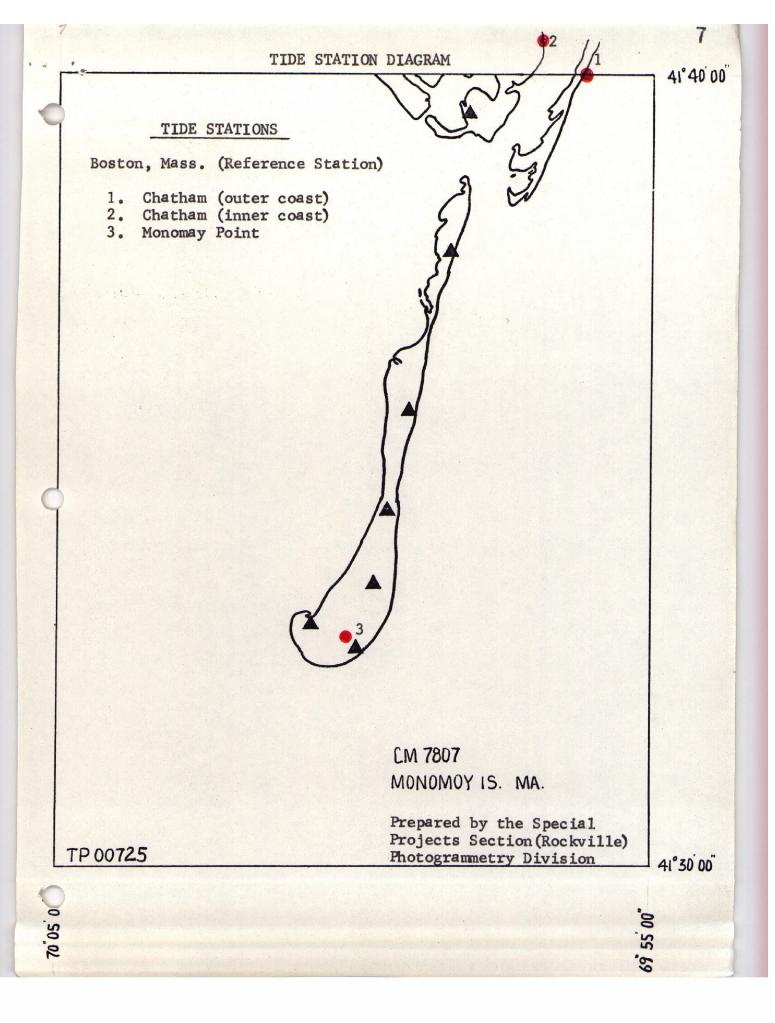

NOAA FORM 76-360 (3-72)			NATIONAL OCEAN	IG AND ATMOSPHERIC	NT OF COMMERCE ADMINISTRATION L OCEAN SURVEY
		HISTORY OF FIELD	OPERATIONS	TP-00725	
I. FIELD WIKK	XXXXXXXXXXXXXXXXXXXXXXXXXXXXXXXXXXXXXX	TION FIELD	D EDIT OPERATION		
	OPER	TATION	N/	ME	DATE
1. CHIEF OF FIEL	D PARTY		Jim Shea	ļ	3/78
		RECOVERED BY	Jim Sh <u>e</u> a		10
2. HORIZONTAL C	ONTROL	ESTABLISHED BY	Jim Shea		П
		PRE-MARKED OR IDENTIFIED BY	Jim Shea		11
	_	RECOVERED BY	NA NA		
3. VERTICAL CON	TROL	ESTABLISHED BY	NA NA		
		PRE-MARKED OR IDENTIFIED BY	NA NA		
4. LANDMARKS AN		OVERED (Triangulation Stations) BY	NA NA		
AIDS TO NAVIG		LOCATED (Field Methods) BY	NA NA		
<u> </u>		TYPE OF INVESTIGATION	117.1	•	
5. GEOGRAPHIC N	AMES	COMPLETE			
INVESTIGATION		SPECIFIC NAMES ONLY	}		
		X NO INVESTIGATION	NA		
6. PHOTO INSPEC	TION	CLARIFICATION OF DETAILS BY	NA		
7. BOUNDARIES A	NO LIMITS	SURVEYED OR IDENTIFIED BY	NA		<u></u>
II. SOURCE DATA 1. HORIZONTAL C	ONTRO! IDEN	TIFIED.	2. VERTICAL CONT	ROL IDENTIFIED	
	-marked	. 11 120	NA	NOT IDENTIFIED	
	mu i keu		 		
78Z(C) 2291	H_3_MA 10	178 & H-2-MA-1978	PHOTO NUMBER	STATION DESI	GNA HON
	H-1-MA-19				
78Z(C) 2299	H-4-MA-19				
78Z(C) 2303	H-5-MA-19		1		
78Z(C) 2307	Morris Is	land 1978			
78Z(C) 2295	Monomoy F	t. Lighthouse 1875			
3. PHOTO NUMBER	RS (Clarification	of details)			
	•	441, 2 44 5, 2447, 2449 (B&W Matte pri	nts)	
4. LANDMARKS AN	ND AIDS TO NA	VIGATION IDENTIFIED			
None					
HOHE					
PHOTO NUMBER		OBJECT NAME	PHOTO NUMBER	OBJECT N	AME
			J		
			<u> </u>		
5. GEOGRAPHIC N	AMES:	REPORT X NONE	6. BOUNDARY AND	LIMITS: REPOR	T NONE
7. SUPPLEMENTA	L MAPS AND PI	ANS			
None					
		h books, etc. DO NOT list data submit		-	
		ncerning horizontal con tion Division (CAM 101)			is on
Norfolk		5.50 51.1516N (ONIT 101)	, ,,,,,,,,,,,,,,,,,,,,,,,,,,,,,,,,,,,,,		
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NOAA FOR (3-72)	RM 76-36D		N/	ATIONAL OCEANIC	U. S. DEPARTMEN	NT OF COMMERCE ADMINISTRATION
Ì		RECO	RD OF SURVEY	Y USE	TP-00725	
I. MANUSC	CRIPT COPIES					
	со	MPILATION STAGES	.s		DATE MANUSCRI	PT FORWARDED
	DATA COMPILED	DATE	REI	MARKS	MARINE CHARTS	HYDRO SUPPORT
Compi	lation Completed	2/20/80	Class III Edit not s	Map - Field scheduled.	·	
	Review Prior to tration	3/21/80	Class III Edit will performed.		4/28/80	
	AARKS AND AIDS TO NAVIGA					
1. REP	ORTS TO MARINE CHART DI	IVISION, NAUTICAL	DATA BRANCH			
NUMBER	CHART LETTER NUMBER ASSIGNED	DATE FORWARDED		RE	MARKS	
3		2/11/80				
	REPORT TO MARINE CHART REPORT TO AERONAUTICA	•				
III. FEDER	RAL RECORDS CENTER DAT	ſA .				
2. [] 3. [X]	BRIDGING PHOTOGRAPHS; CONTROL STATION IDENTI SOURCE DATA (except for G ACCOUNT FOR EXCEPTION DATA TO FEDERAL RECOR	IFICATION CARDS; Geographic Names Rej NS: RDS CENTER, DATI	FORM NOS	5 567 SUBMITTED E	BY FIELD PARTIES. A FORM 76-36C.	_
IV. SURVI	EY EDITIONS (This section s	JOB NUMBER) edition is registere	TYPE OF SURVEY	
SECOND	TP	_ (2) PH		RI		SURVEY
EDITION					. 🗆 ıv. 🗆 v.	FINAL
	SURVEY NUMBER	JOB NUMBER			TYPE OF SURVEY	
THIRD EDITION	DATE OF PHOTOGRAPH			□ R.E.	MAP CLASS	GURVEY
	SURVEY NUMBER	JOB NUMBER			TYPE OF SURVEY	FINAL
FOURTH	TP	_ (4) PH		☐ RE	EVISED RES	ÜRVĖY
EDITION	DATE OF PHOTOGRAPH	HY DATE OF FIL	ELD EDIT	п. п	MAP CLASS	Π



TP-00725

This map is the only map in Job CM-7807, Monomoy Island, Massachusetts. The map was compiled as the result of special requests from the U.S. Coast Guard and Congressman Studds of Massachusetts. Severe storms have caused a suspected shift in the Pollock Rip Channel and the Coast Guard has been requested to replace the buoy system of the channel. Before the buoys can be replaced, this map is needed in the area to determine the extent of changes in the channel.

Field operations, which began in March 1978, generally consisted of aerial photography and pre-marking of horizontal control. Bridging and compilation photography was flown in March, July, and August of 1978.

Aerotriangulation and compilation photography was furnished at 1:20,000 scale from natural color film and black-and-white infrared film.

Two strips of the 1:20,000 scale color photography were bridged by analytic aerotriangulation methods. Seven horizontal control stations were used in the strip adjustments. All horizontal control point residuals were within NOS bridging accuracy requirements.

Compilation photography was the 1:20,000 scale color and black-and-white infrared photos. The map was compiled using both graphic and stereo instrument methods.

All line work is smooth compilation drafting.

A Chart Maintenance Print was submitted to the Marine Chart Division.

The following items are registered in the Bureau Archives:

- 1. A plastic copy of the map (1:20,000 scale).
- 2. A Descriptive Report.

A negative is on file in the Reproduction Division.

A negative is on file in the Photo Map and Imagery Information Section.

All field data are filed in the National Archives.

FIELD INSPECTION

There was no field inspection prior to compilation. Field work accomplished was limited to the recovery and identification of horizontal control necessary for aerotriangulation.

PHOTOGRAMMETRIC PLOT REPORT MONOMOY ISLAND, MASSACHUSETTS CM-7807 April 1978

AREA COVERED

The area covered by this project is the Monomoy Island area of Massachusetts. One 1:20,000 manuscript, TP-00725, covered the entire project area.

METHOD

Strip #1 of 1:20,000 bridging photography was measured by analytic aerotriangulation methods. Six of the seven horizontal control stations used in the strip adjustment were paneled. The other was an office identified lighthouse. Vertical control was obtained by using shoreline elevation points. No tie points were used.

Ratio points were drilled Strip #1 and pricked on 1:10,000 contacts of Strip #2.

A plotter tape for Strip #1 was generated and turned over to compilation for plotting.

ADEQUACY OF CONTROL

All horizontal control point residuals were within NOS bridging accuracy requirements. The location of horizontal control was adequate.

The location and adjustment of the vertical control was satisfactory.

PHOTOGRAPHY

Due to the degree of overlap in Strip #1, every other photograph was used in the bridging strip. Coverage and quality of the photography was adequate.

Submitted by:

Robert E. Fisher

Approved and Forwarded:

Dow O. norma

Don O. Norman


Acting Chief, Aerotriangulation Section

78Z(C)2307.

78Z(C) 2332

CONTROL

- 1. H-2-MA-78
- 2. H-3-MA-78
- 3. MONOMOY PT. LICHTHOUSE
- 4. H-1-MA-78
- 5. H-4-MA-78
- 6. H-5-MA-78
- 7. MORRIS ISLAND 1978

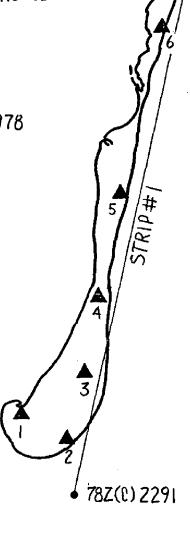

CM 7807 MONOMOY IS. MA.

TP 00725

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NOAA FORM 76-41				D.S.U	U.S. DEPARTMENT OF COMMERCE
		DESCRIPTIV	DESCRIPTIVE REPORT CONTROL RECORD	ĺ	
MAP NO.	TJOB NO.	۲.	GEODETIC DATUM	ORIGINATING ACTIV	Special Prejects Section, (Rockville)
17-00(23	1021-47				
STATION NAME	SOURCE OF INFORMATION (Index)	AEROTRI- ANGULATION POINT NUMBER	COORDINATES IN FEET STATE Hossochuse Hs ZONE Main Gud	GEOGRAPHIC POSITION	REMARKS
	2/2/2		X= 1,018,357.75	\$ 41-39-31.5-23 ×	plottedo
MCRRIS ISLAND 1978 (Firld position)	Position	307100	4" 243,802.55	1 69-58-08.488 V	by Goodesy (NOS)
			χ=	4 41-34- 30.857 V	Not plotted
	6.25-1.220		y=	λ 69-58-07.632	on map.
MONOHOY POINT LIFE			±χ	4 41-33-11.969V	*,
57.4 TION CUPOLA 1906			=h	1 20-00-31.465	Not plotted on MAD.
			=χ	4 41-39-19.861 V	
STAGE HARBOR LIGHT 1954	C.P.5-1890		<i>y</i> =	X 69-59-06.039	
l			14.121,210,1 =X	¢ 41-33-33,199 -	
	6.05-P.213	295100	4= 207 416-51	1 69-59-39.091	
			χ=	¢ 41-39-30.914 ×	
STAGE HARBOR LIGHTHOUSE	6.1.5- 1.165		j/a=	λ 69-59-03-227	
			=χ	ф	
			y=	γ	
			χ=	Φ.	
			<i>y=</i>	γ	
			<i>χ</i> =	•	
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COMPUTED BY:		DATE	COMPUTATION CHECKED BY	1 110	DATE
LISTED BY		DATE SO	LISTING CHECKED BY	1. Sollanch	DATE 3/6/80
HAND PLOTTING BY		DATE	HAND PLOTTING CHECKED BY	911	5
		SUPERSEDES N	ES NOAA FORM 75-41, 2-71 EDITION WHICH IS OBSOLETE	ICH IS OBSOLETÉ.	

31. Delineation

17

This map was compiled using both stereo instrument and graphic compilation methods. Map points and planimetric features were compiled using the Wild B-8S Aviograph Stereoplotter and the bridged natural color photography. Planimetric features consist of waterfront structures, man-made alongshore and offshore details, and interior cultural features. The instrument compilation provided additional horizontal control necessary for the graphic compilation. Graphic compilation from ratioed prints of the black-and-white infrared photography was used to depict the mean high and approximate mean low water lines, and drainage features. The natural color photography, taken in August 1978, was used graphically to update the instrument compilation, and to delineate the marsh and shallow areas. All features mapped are based on office interpretation of the photography.

Due to lack of photo coverage, a portion of the shoreline along Harding Beach was not compiled.

32. Control

Refer to the Photogrammetric Plot Report bound with this Descriptive Report.

The identification, density, and placement of horizontal and vertical control was adequate.

- 33. Supplemental Data None
- 34. Contours and Drainage

Contours are not applicable.

All drainage is from office interpretation of the black-and-white infrared photography.

35. Shoreline and Alongshore Details

The mean high water line and the approximate mean low water line were compiled from office interpretation of the tide controlled, black-and-white, infrared photography. The outermost water/land interface photographic image was used to compile the approximate mean low water line. Minimal water penetration is apparent on these photographs, therefore; some areas compiled within the approximate mean low water line symbol, may be wet to a small degree.

Alongshore and foreshore features were delineated by office interpretation of the color photography. Shallow water areas depicted on this map do not represent specific water depths and were compiled as an aid to the hydrographer.

There was no preliminary field inspection of the shoreline.

36. Offshore Detail

10

No unusual problems were encountered in compiling details offshore.

37. Landmarks and Aids

Refer to the 76-40 listings bound with this Descriptive Report for those charted landmarks and fixed aids identifiable on the compilation photography.

38. Control for Future Surveys

No Form 524 was submitted.

39. Junctions

Refer to Form 76-36B, Item 5, bound in this Descriptive Report.

- 40. Horizontal and Vertical Accuracy No comment
- 41. thru 45. Inapplicable
- 46. Comparison with Existing Maps

A comparison was made with the following USGS quadrangles:

Cheatham, Mass., 1:24,000 scale, 1974 Edition Monomoy Point, Mass., 1:24,000 scale, 1974 Edition

47. Comparison with Nautical Charts

A comparison was made with the following charts:

13229, 1:40,000 scale, 15th Edition, dated 2/3/79. 13244, 1:40,000 scale, 32nd Edition, revised 9/24/77. 13248, 1:20,000 scale, 5th Edition, dated 11/1/75

3

Items to be applied to Nautical Charts immediately - None Items to be carried forward - None

Submitted by,

G. Fromm

Approved and Forwarded:

George M. Ball Chief, Special Projects Section

Review Report T-00725 Shoreline Map

61. General Statement

The map was reviewed in its Class III Map (No field edit) stage by the Quality Control Group. The Descriptive Report prepared for this map, contains all of the pertinent information which may be required by its users.

62. Comparison with Registered Topographic Surveys

None

63. Comparison with Maps of Other Agencies

Refer to Item #46 of the Compilation Report bound with this Descriptive Report.

64. <u>Comparision with Contempary Hydrographic Surveys</u>

None

65. <u>Comparision with Nautical Charts</u>

Refer to Item #47 of the Compilation Report bound with this Descriptive Report.

66. Adequacy of Results and Future Surveys

This map meets the National Standards of Map Accuracy and complies with compilation instructsions and Bureau requirements.

Submitted by,

E. L. Rolle

Approved and Forwarded:

Chief, Photogrammetric Branch

Chief, Photogrammetry Division

1

GEOGRAPHIC NAMES

FINAL NAME SHEET

CM-7807 (Monomoy Island, Mass.)

TP-00725

Atlantic Ocean´
Big Station Pond´
Chatham Harbor´
Chatham Roads´
Harding Beach´
Harding Beach Point´
Hospital Pond`
Lighthouse Marsh´
Monomoy Beach´
Monomoy Island´
Monomoy Point´

Morris Island´
Nantucket Sound´
Oyster Pond River´
Powder Hole´
Quitnessit´
Sears Point´
Stage Harbor´
Stage Island´
Station Pond Marsh´
Trains Creek´

Approved By:

Chief Geographer

16-40 LISTI

COASTAL MAPPING DIDISION PHOTOGRAMMETRIC BRANCH

7.82707四 VERSIONS OATATAB

> NOAA USA

NATIONAL OCEAN SURVEY

DE PARTMENT OF

COMMERCE

SE 1 OF 3 *	MPILATION *
* PAGE * *ORIGINATIN	* COMPILATION * FIELD REPRESENTATIVE * OFFICE COMPILER * DIGITIZER * DATA PROCESSER
PHOTOGR DIV RKVILLE MASSACHUSETTS MONOMOY ISLAND	11/80 **
	* DATE 02/1 FIELD EUIT-CLASS I GREGORY FROMM NOT DIGITIZED HENRY FELICES
* * *	* NO FIELD GREGORY NOT DIG
	# # # # # # # # # # # # # # # # # # #
	27 * VS DETERMINED VERIFIED BY AND OFFICE TIVITLES
00725 7807 0M0Y IS	NA 1927 * POSITIONS DETER AND/OR VERIFIE ACTIVITIES
	E O. E E E E E E E E E E

* NOTE: WHERE THE NAME OF AN AID INCLUDES THE IMMEDIATE GEOGRAPHIC HEADING UNDER WHICH IT IS LISTED * * * A DASH (-) IS USED TO INDICATE THE GEOGRAPHIC HEADING WHICH IS PART OF THE OFFICIAL NAME. *

SURVEY METHODS

21*

ESTABLISHED BY PHOTOGRAMMETRIC METHOUS.

VERSIONE 782707 g

### PAGE 2 OF 3 EANU	76-40 LISTI		PHOTOGRAMMETRIC BRANCH COASTAL MAPPING DIDISION	NAT J	의 O R 전 N 전	A A	VERSIC 78270
THE FOLLOWING OBJECTS HAVE FEET INSPECTED FROM SEARARD TO DETERMINE THEIR VALUE AS LANDMARK NAME * PUT TRIANGLATION RASES IN(); * LAITOUR ON AND THE * OF LOCATION AFFECT OF THE * OF LOCATION AFFECT OF THE * OF LOCATION AFFECT OF THE * OF] 	5 I 7	FOR CHART REVISED	PT UN STA OCALI	OTGGR DIV RKVILL SSACHUSETTS NOMOY ISLANU	PAGE IGINATIN COMPI	OF 3 ACTI TION
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NATIONAL OCEAN SURVEY

PHOTOGRAMM ETRIC BRANCH COASTAL MAPPING DIDISION

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NOAA COMMERCE USA DEPARTMENT OF

AFFECTED ACT IVITY * CHARTS 13229 13248 HAVE BEEN INSPECTED FROM SEAWARD TO DETERMINE THEIR VALUE AS LANDMARKS COMPILATION 9 *ORIGINATING FIELD METHOD AND DATE PAGE OF LOCATION NOT #78Z(C)2307* 139.8 06120* 03/06/78 CFFICE PHOTOGR DIV RKVILLE MONOMOY ISLAND MASSACHUSETTS 06120* ¥ GEO ALIEK* 02/11/90 921.2 Σ. Ο d D P 05 1T 10 N DATE * RPT UNII STATE LOCALITY 29.86 59 06.04 LO NG IT UD E L AT ITUDE 39 69 , * NONFLOATING AIDS FOR CHARTS * PUT TRIANGULATION NAMES IN(); RECORD REASON FOR DELETION * (STAGE HARBOR LIGHT 1954) N AN TUCK ET SOUND STAGE HARBOR UESCRIPTION THE FOLLOWING OBJECTS MONOMOY IS* NA 1927 TP-00725 CM-7807 *CHARTING * -LIGHT NAME J 0 B PRJ DIM 入入が

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National Archives Data T-00725

Bridging photography:

78Z(C) 2291, 93, 95, 97, 99, 2301, 03, 05, 07 and 09

78Z(C) 2332, 34, 36, 38, 40, and 44

1 Horizontal control diagram

Contact B&W from color photos with horizontal control identfication:

78Z(C) 2435, 37, 41, 45, 47 and 49

Horizontal control data

Example field sketch and photos of premarked control

RECORD OF APPLICATION TO CHARTS

FILE WITH DESCRIPTIVE REPORT OF SURVEY NO.

INSTRUCTIONS

A basic hydrographic or topographic survey supersedes all information of like nature on the uncorrected chart.

1. Letter all information.

2. In "Remarks" column cross out words that do not apply.

3. Give teasons for deviations, if any, from recommendations made under "Comparison with Charts" in the Rev

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CHART	DATE	CARTOGRAPHER	REMARKS .
13248	6/13/50	Barbara Loreto	Full Pare Before After Verification Review Inspection Signed Via
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	,	10	marsh areas & ZWL
13229	6/17/80	Barbara Lorely	Full Part Before After Verification Review Inspection Signed Via
(114)	777	8	Drawing No. #17 A-B Revised shoreline
			maesh areas é LWL
13244	6/20/80	Barbara Lock	Full Pare Before After Verification Review Inspection Signed Via
(250)	1777	7 8	Drawing No. 28 Revised Shareline,
] ,		MARSH Areas & LWL
12237	4/24/00	Bondar Lock	Full Part Bofore After Verification Review Inspection Signed Via
(1209)	1770	8	Drawing No. # 47 Revised Share line,
		1	LWL
13246	9-25-80	Diwylie	Full Park Harrier Verification Review Inspection Signed Via
			Drawing No. 39 Revised Shoreline, Luly Marsh
			Full Part Before After Verification Review Inspection Signed Via
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